UNIVERSITY OF CALIFORNIA, SANTA BARBARA

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SANTA BARBARA • SANTA CRUZ

OFFICE OF DESIGN & CONSTRUCTION SERVICES and PHYSICAL FACILITIES

CONTRACTING SERVICES Building 439 Santa Barbara, California 93106-1030 Telephone (805) 893-3356 Fax (805) 893-8592

SENT VIA:	
	imes

FAX ON THIS DATE HAND DELIVERY ON THIS DATE FEDERAL EXPRESS ON THIS DATE UNITED PARCEL SERVICE ON THIS DATE

HOLDERS OF PLANS AND SPECIFICATIONS:

Engineering II-Bldg. 503, Laboratory Remodel, Rooms 1119B & 1119E Project No. FM090301S/987722 <u>Addendum No. 1</u>

May 29, 2009

Enclosed is **ADDENDUM NO. 1** to the Construction Documents on the above-captioned project.

Bid date has been changed from, Tuesday, June 2, 2009 at 2:30 P.M. to Friday, June 5, 2009 at 2:30 P.M. to be held at:

CONTRACTING SERVICES Facilities Management, Bldg. 439, Door #E, Reception Counter University of California, Santa Barbara Santa Barbara, CA 93106-1030.

Late arrivals shall be disqualified. Please allow time for unforeseen traffic delays, securing a parking permit and potential parking problems.

Anna Galanis Director, Contracting Services

Engineering II-Bldg. 503, Laboratory Remodel, Rooms 1119B and 1119E

ADDENDUM NUMBER 1

to the

CONSTRUCTION DOCUMENTS

May 29, 2009

<u>General</u>

The following changes, additions or deletions shall be made to the following documents(s); and all other conditions shall remain the same.

I. ADVERTISEMENT FOR BIDS

Item No.

1. <u>Second page, first sentence beginning with "Bid Deadline"</u>, Change to read in it's entirety:

"Bid Deadline: Sealed bids must be received on or before 2:30 P.M. on <u>Friday, June 5, 2009</u>. Sealed Bids will be received only at Contracting Services, Facilities Management, Building #439, Door #E, Reception Counter, University of California, Santa Barbara, Santa Barbara, California, 93106-1030."

II SUPPLEMENTARY INSTRUCTIONS TO BIDDERS

Item No.

1. Number 4, Change to read in it's entirety:

"Bids will be received on or before the Bid Deadline: <u>2:30 P.M., Friday, June 5, 2009</u> and only at: Contracting Services, Facilities Management, Building #439, Door #E, Reception Counter, University of California, Santa Barbara, Santa Barbara, California, 93106-1030."

III. DRAWINGS

Item No.

 Drawing No. A2.1, FLOOR PLANS. Replace the Finish Schedule and the Finish Code List on drawing A2.1 with the attached Finish Schedule & Finish Code List A2.1, dated 5/28/09. Engineering II-Bldg. 503, Laboratory Remodel, Rooms 1119B and 1119E

- 2. Drawing No. A2.2, CONTAINMENT VESSEL BASE PLATES. **Replace** in its entirety with attached drawing A2.2, dated 5/28/09.
- 3. <u>Drawing No. S1, STRUCTURAL PLAN, GEN. NOTES & DETAILS.</u> <u>Replace in its</u> <u>entirety with attached drawing S1, dated 5/28/09.</u>
- 4. <u>Drawing No. P2.0, PLUMBING PLAN.</u> **Revise** the Plumbing Plan with attached drawing ADD 1, dated 5/28/09.

Revised as follows: The point of connection for the purified NH3 line in room 1119E has been revised.


- 5. <u>Drawing No. E2.1, ELECTRICAL DEMOLITION & POWER PLANS.</u> **Replace** in its entirety with attached drawing E2.1, dated 5/28/09.
- 6. <u>Drawing No. E3.1, ELECTRICAL ROOF PLAN.</u> **Replace** in its entirety with attached drawing E3.1, dated 5/28/09.


END OF ADDENDUM NO. 1

ADDENDUM #1 - EXISTING FLOOR IN ROOM 1119J IS NOT TO BE REPLACED. PATCH ONLY AS REQ'D w/ STATIC CONTROL RESILIENT FLOORING TO MATCH EXISTING.

ROOM	ROOM NAME	FLOOR BASE WALLS					CL'G. &	
ROOM	ROOMINAME						ULG. O	
	<u></u>	Dm		NORTH	EAST	SOUTH	WEST	DUCTS
1119J	NEW REACTOR ROOM	$\{F2\}$	B1	W1	W1	W1	W1	W1
	NEW DOOR #2	\square			W2		W2	
1119B	(E) LAB	F2	B1	W1	-	-	W1	W1
1119E	(E) LAB	F2	B1	W1	W1	-	-	NONE
	MAINTENANCE YARD	E EXPOSED CONDUIT MOUNTED ON WALL PRIMED AND PAINTED TO MATCH EXIST						
	EXTERIOR BREEZEWAY	EXPOSED CONDUIT IN UNISTRUT HANGERS TO BE PRIMED AND PAINTED TO MATCH EXISTING						

		FINISH CODE LIST
SURFACE	CODE	
FLOOR	F1 /	STATIC CONTROL RESILIENT FLOORING TO MATCH EXISTING.
	F2 {	PATCH AS REQ'D w/ STATIC CONTROL RESILIENT FLOORING
BASE	B1	4" TOP SET RUBBER BASE TO MATCH EXISTING.
	B2	-
WALLS,	W1	PAINT - COLOR TO MATCH EXISTING, EGG SHELL FINISH.
CEILINGS,	W2	PAINT - COLOR TO MATCH EXISTING, SEMI-GLOSS FINISH.
DUCTWORK,	W3	-
& DOORS		

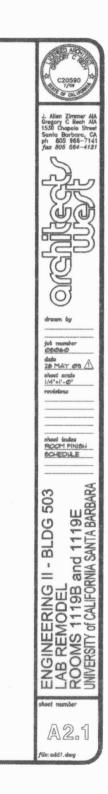

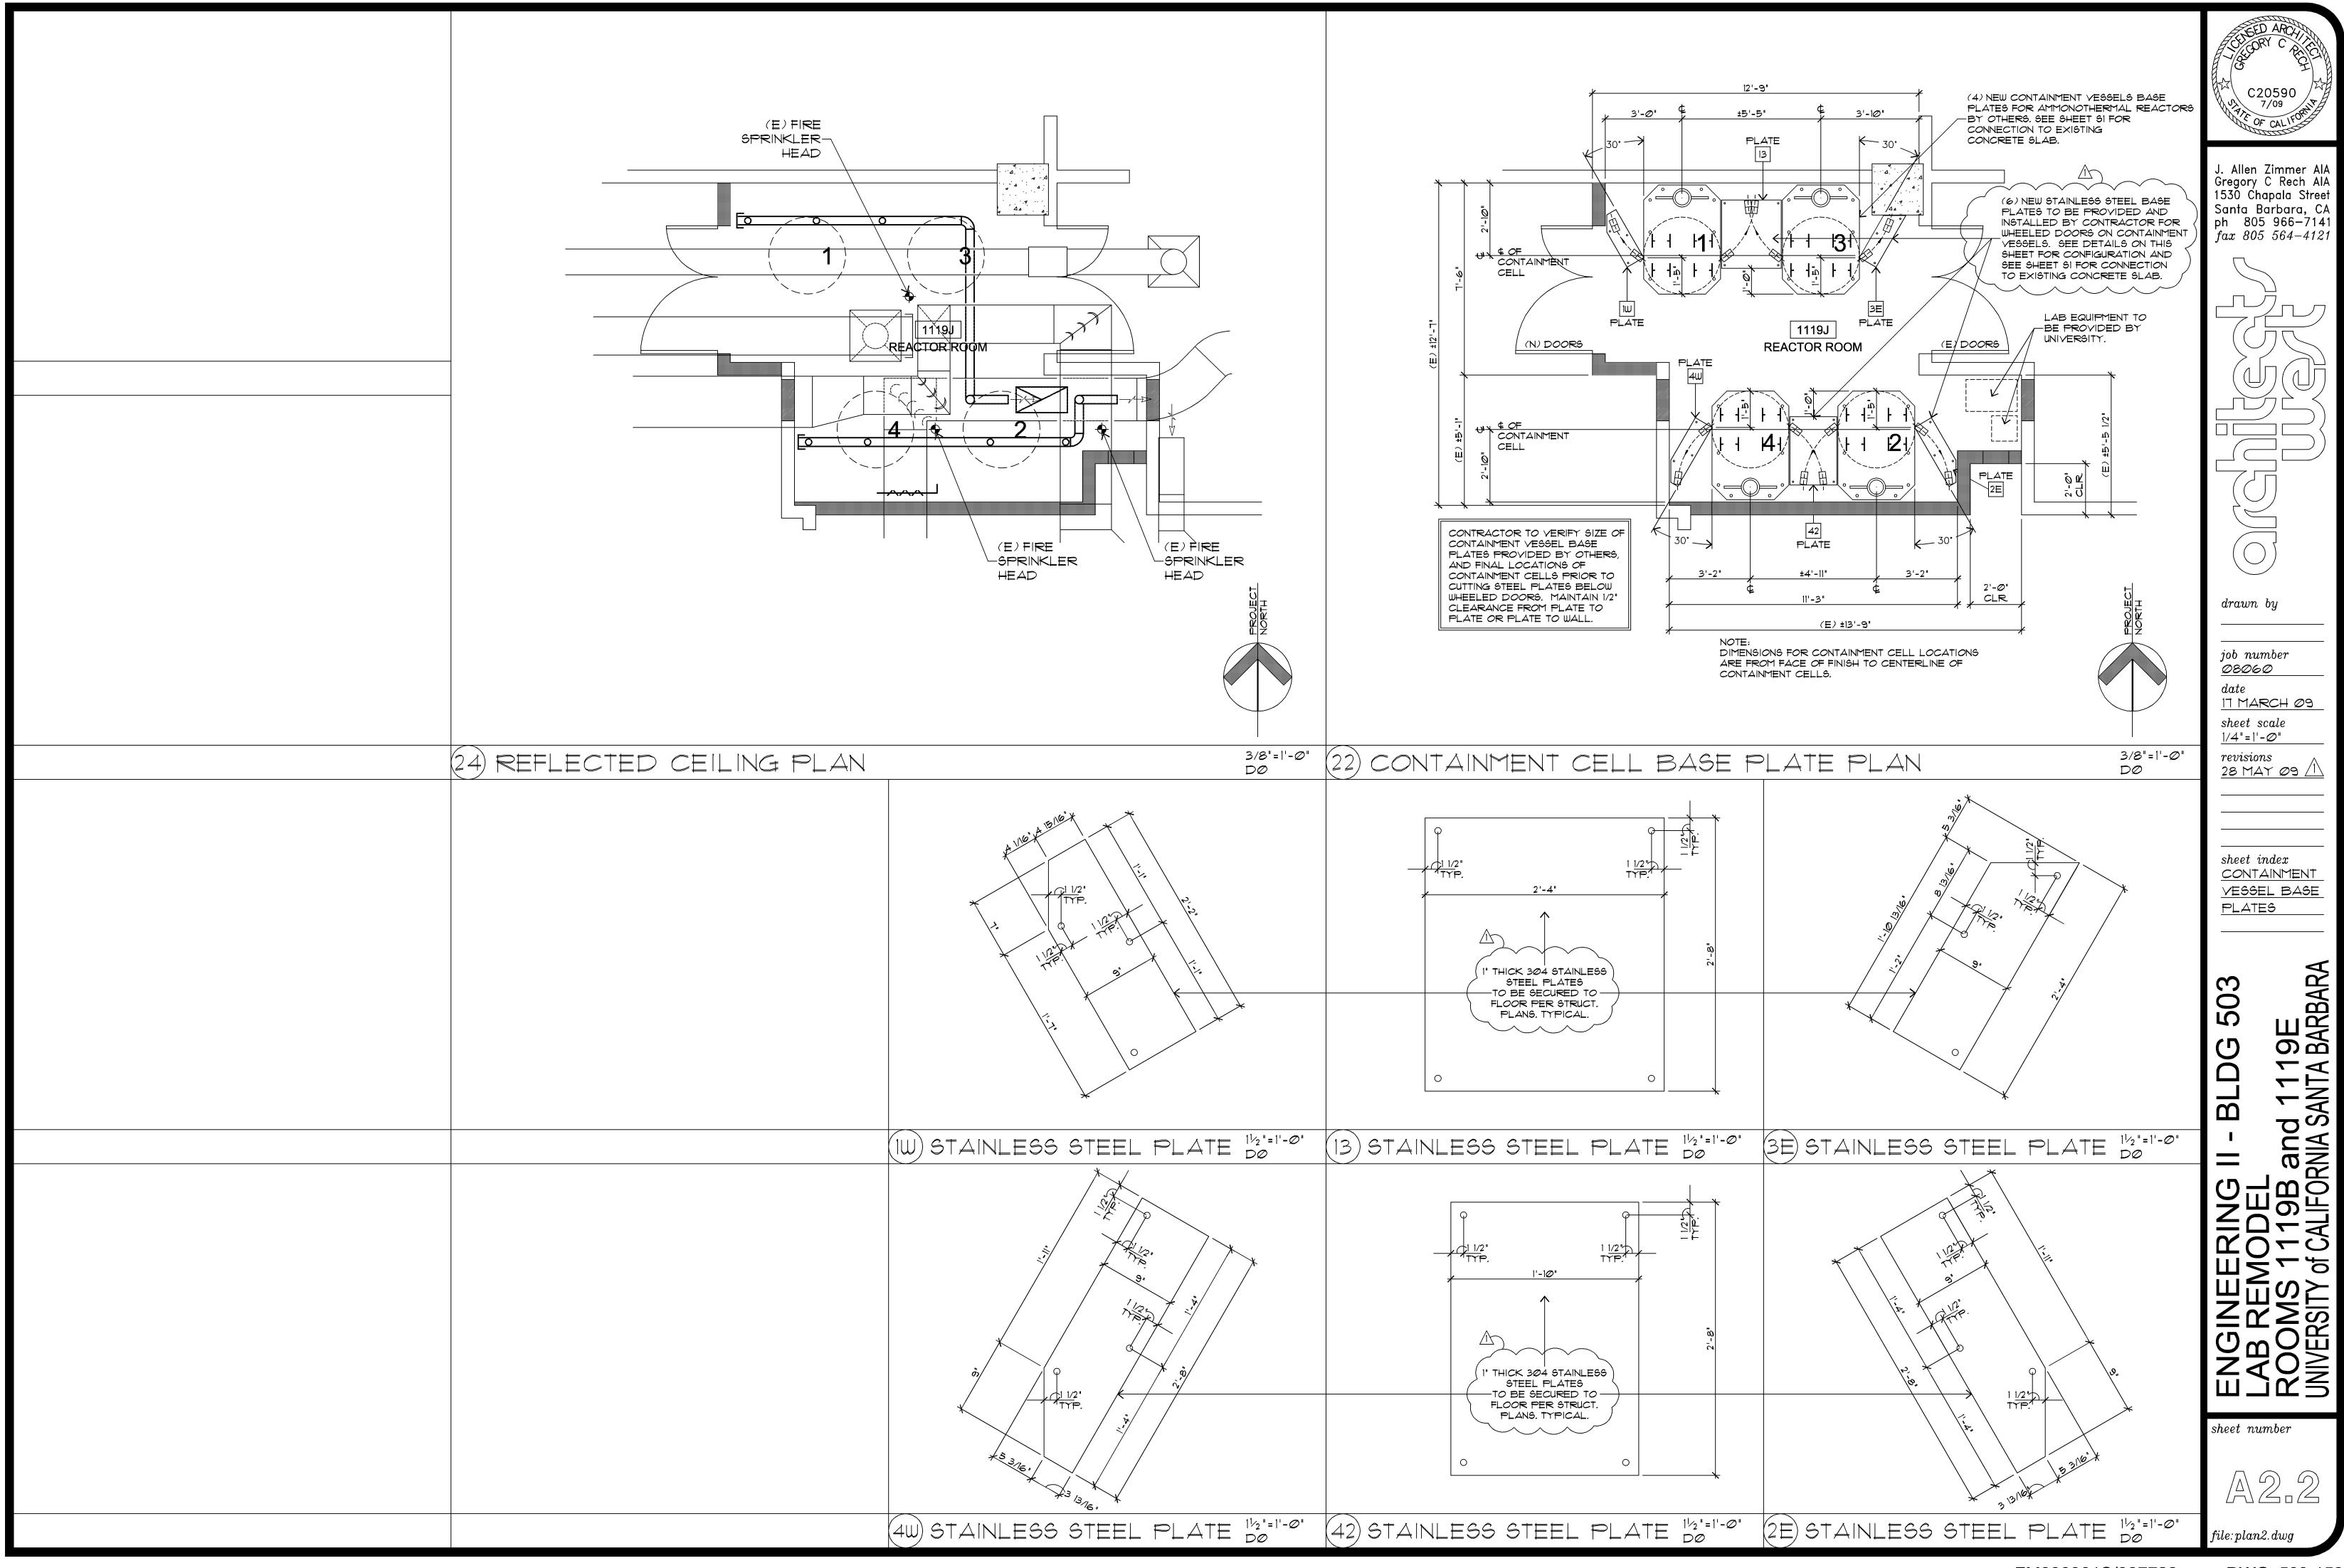


FM090301S/987722

DWG. 503-150

GENERAL NOTES


- IN CASE OF A POSSIBLE CONFLICT OR DISCREPANCY BETWEEN STRUCTURAL AND
- SPECIFICALLY REFERENCED.


 $S_{s} = 2.105$ $S_{1} = 0.805$ $S_{DS}^{\prime} = 1.40$ $S_{D1}^{\prime} = 0.805$ $F_{P} = 0.63W$

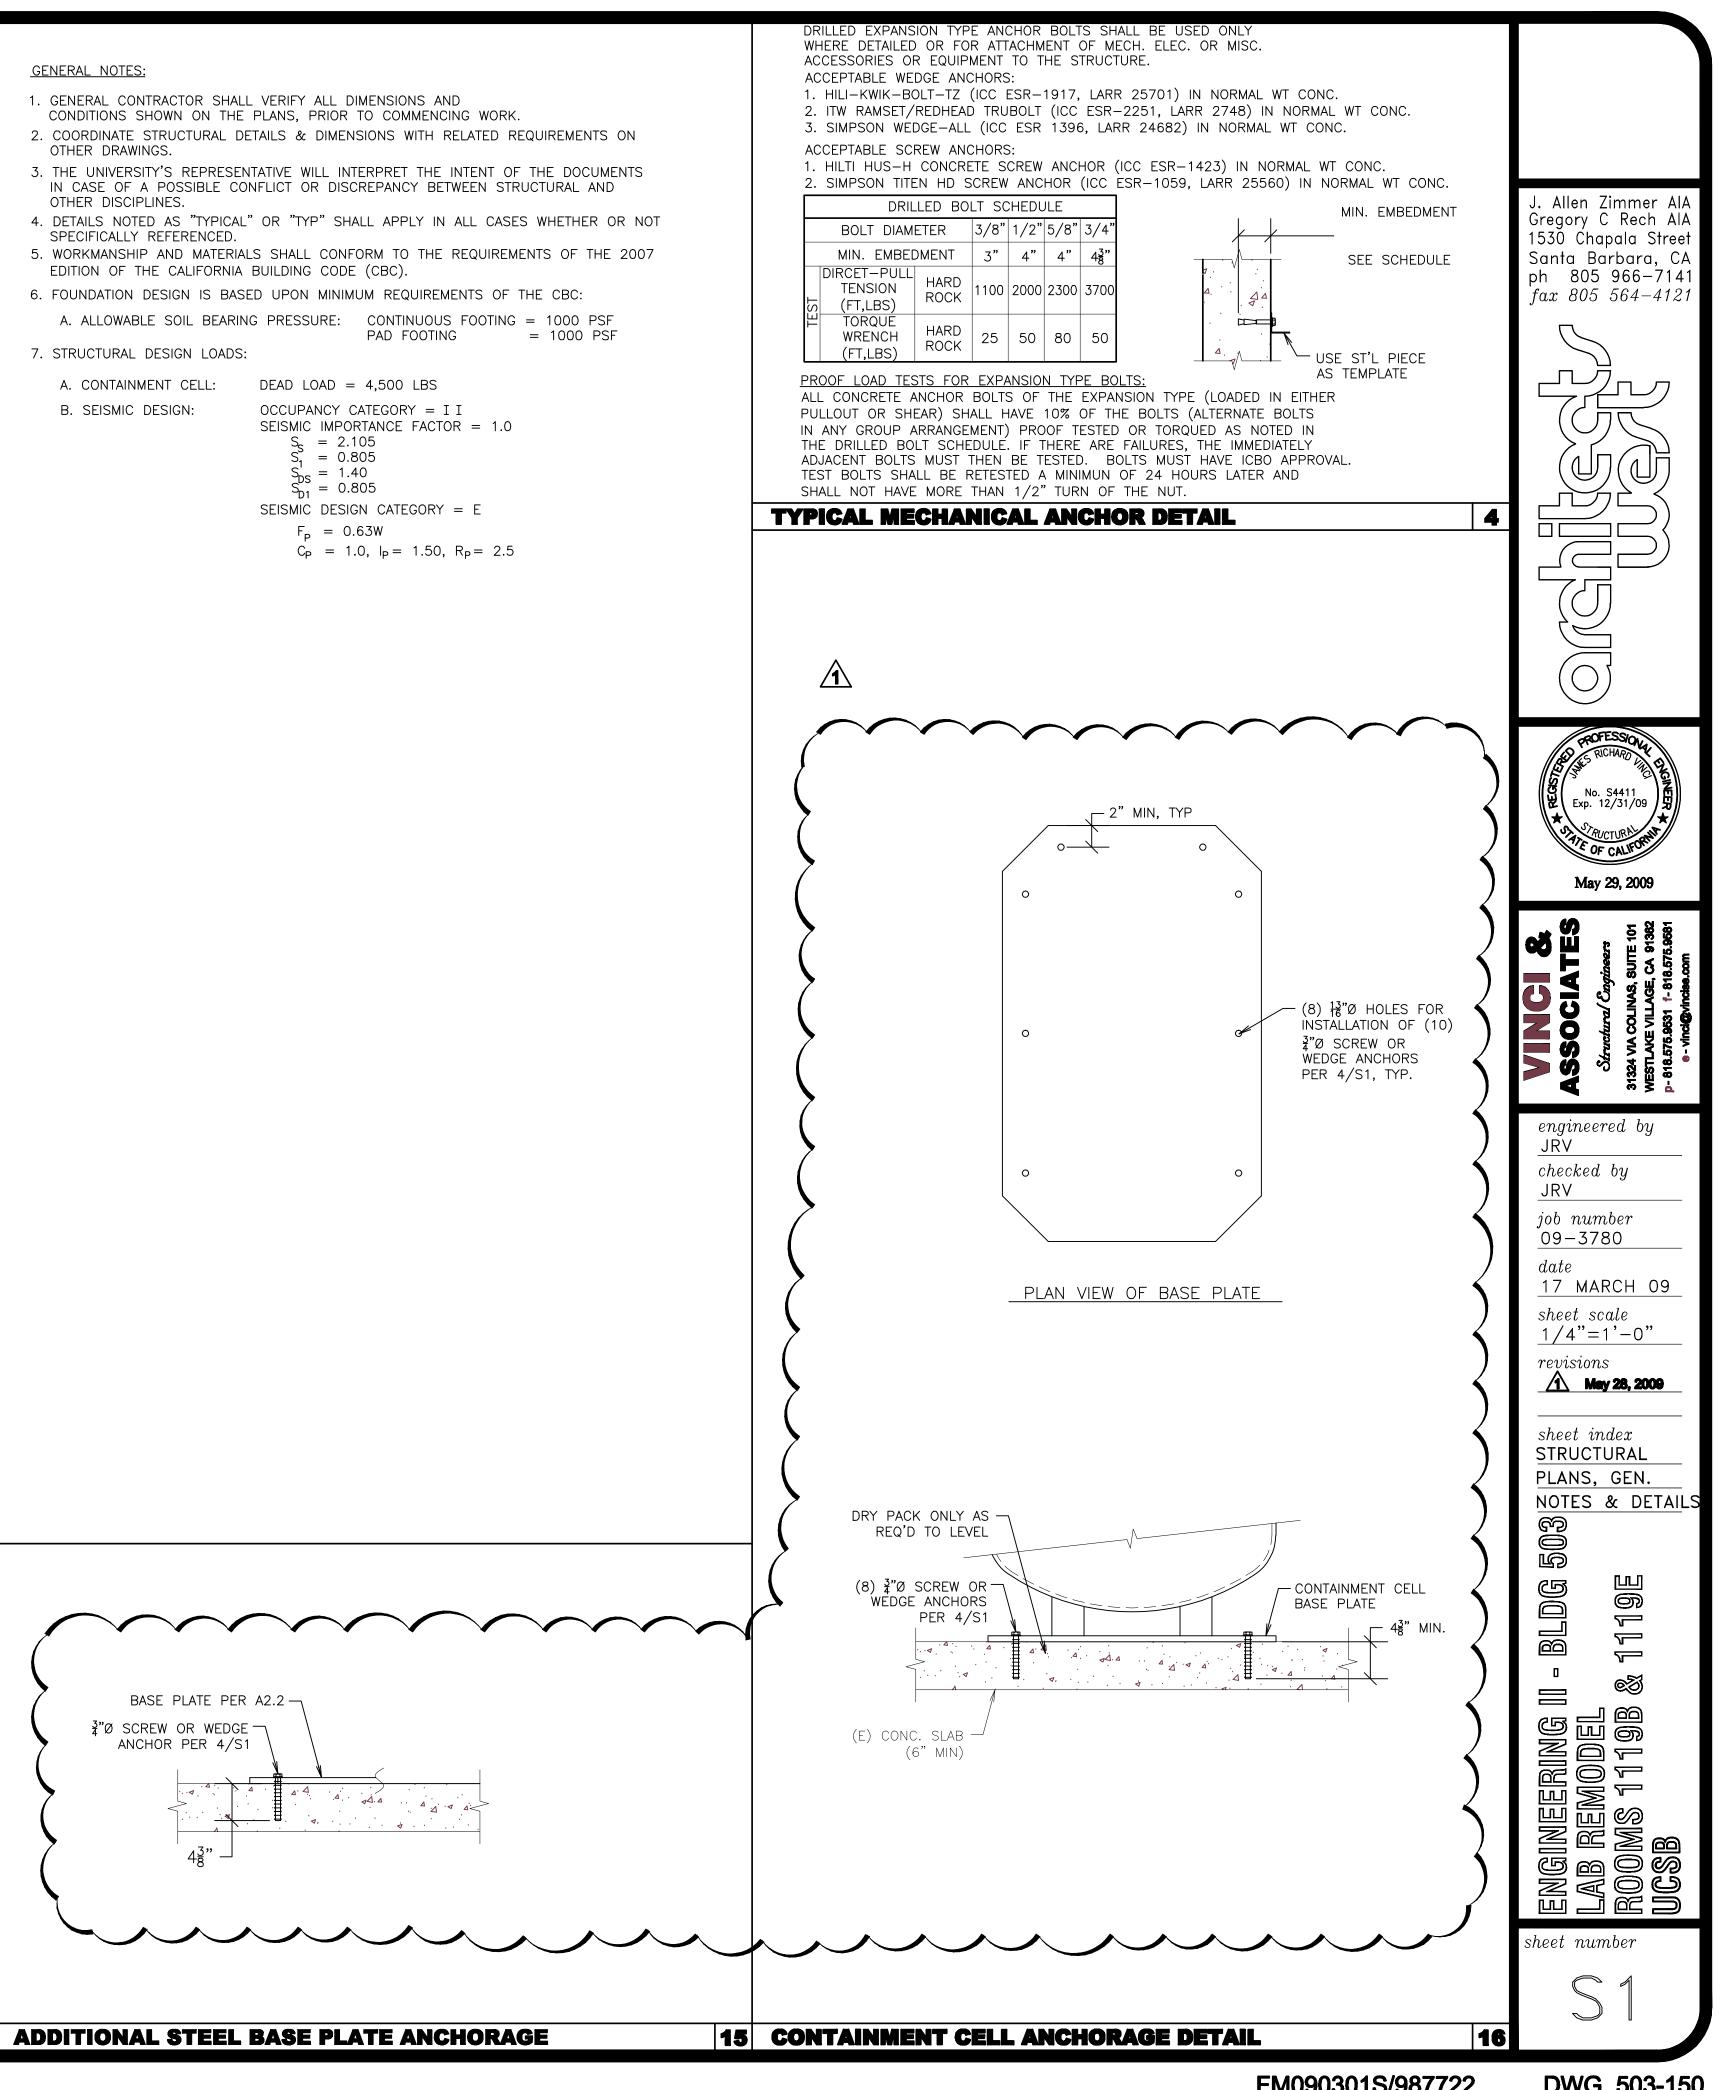


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DWG. 503-150



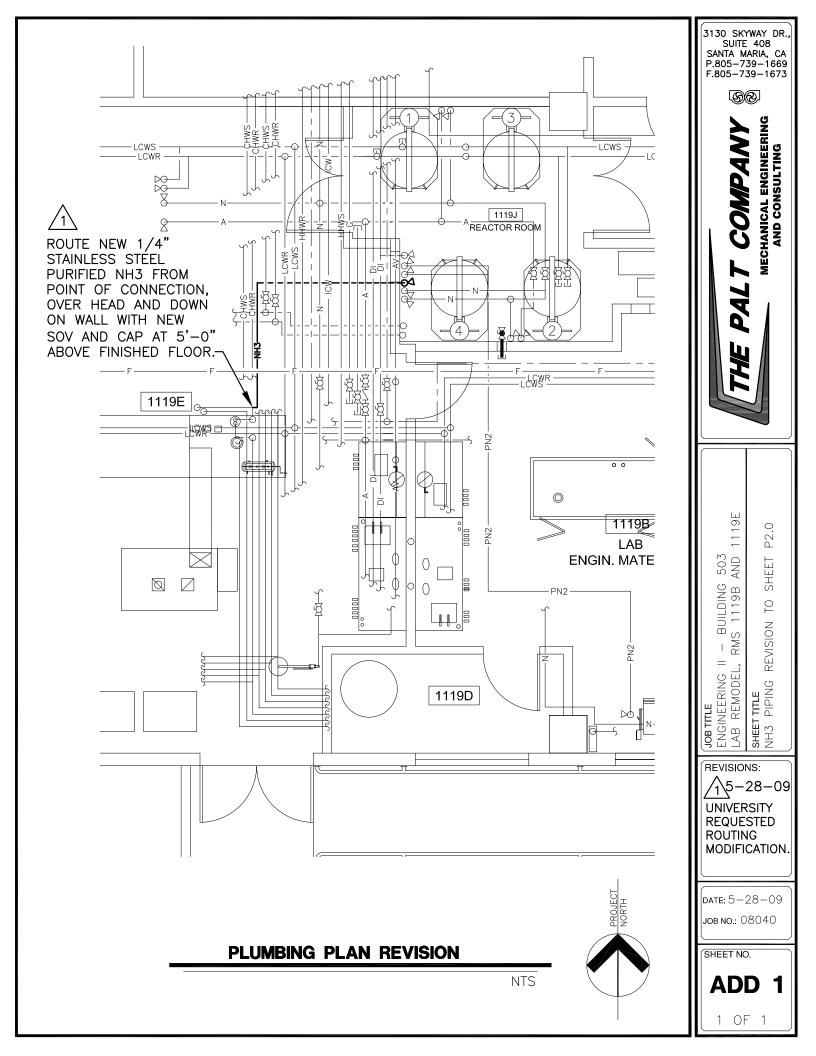


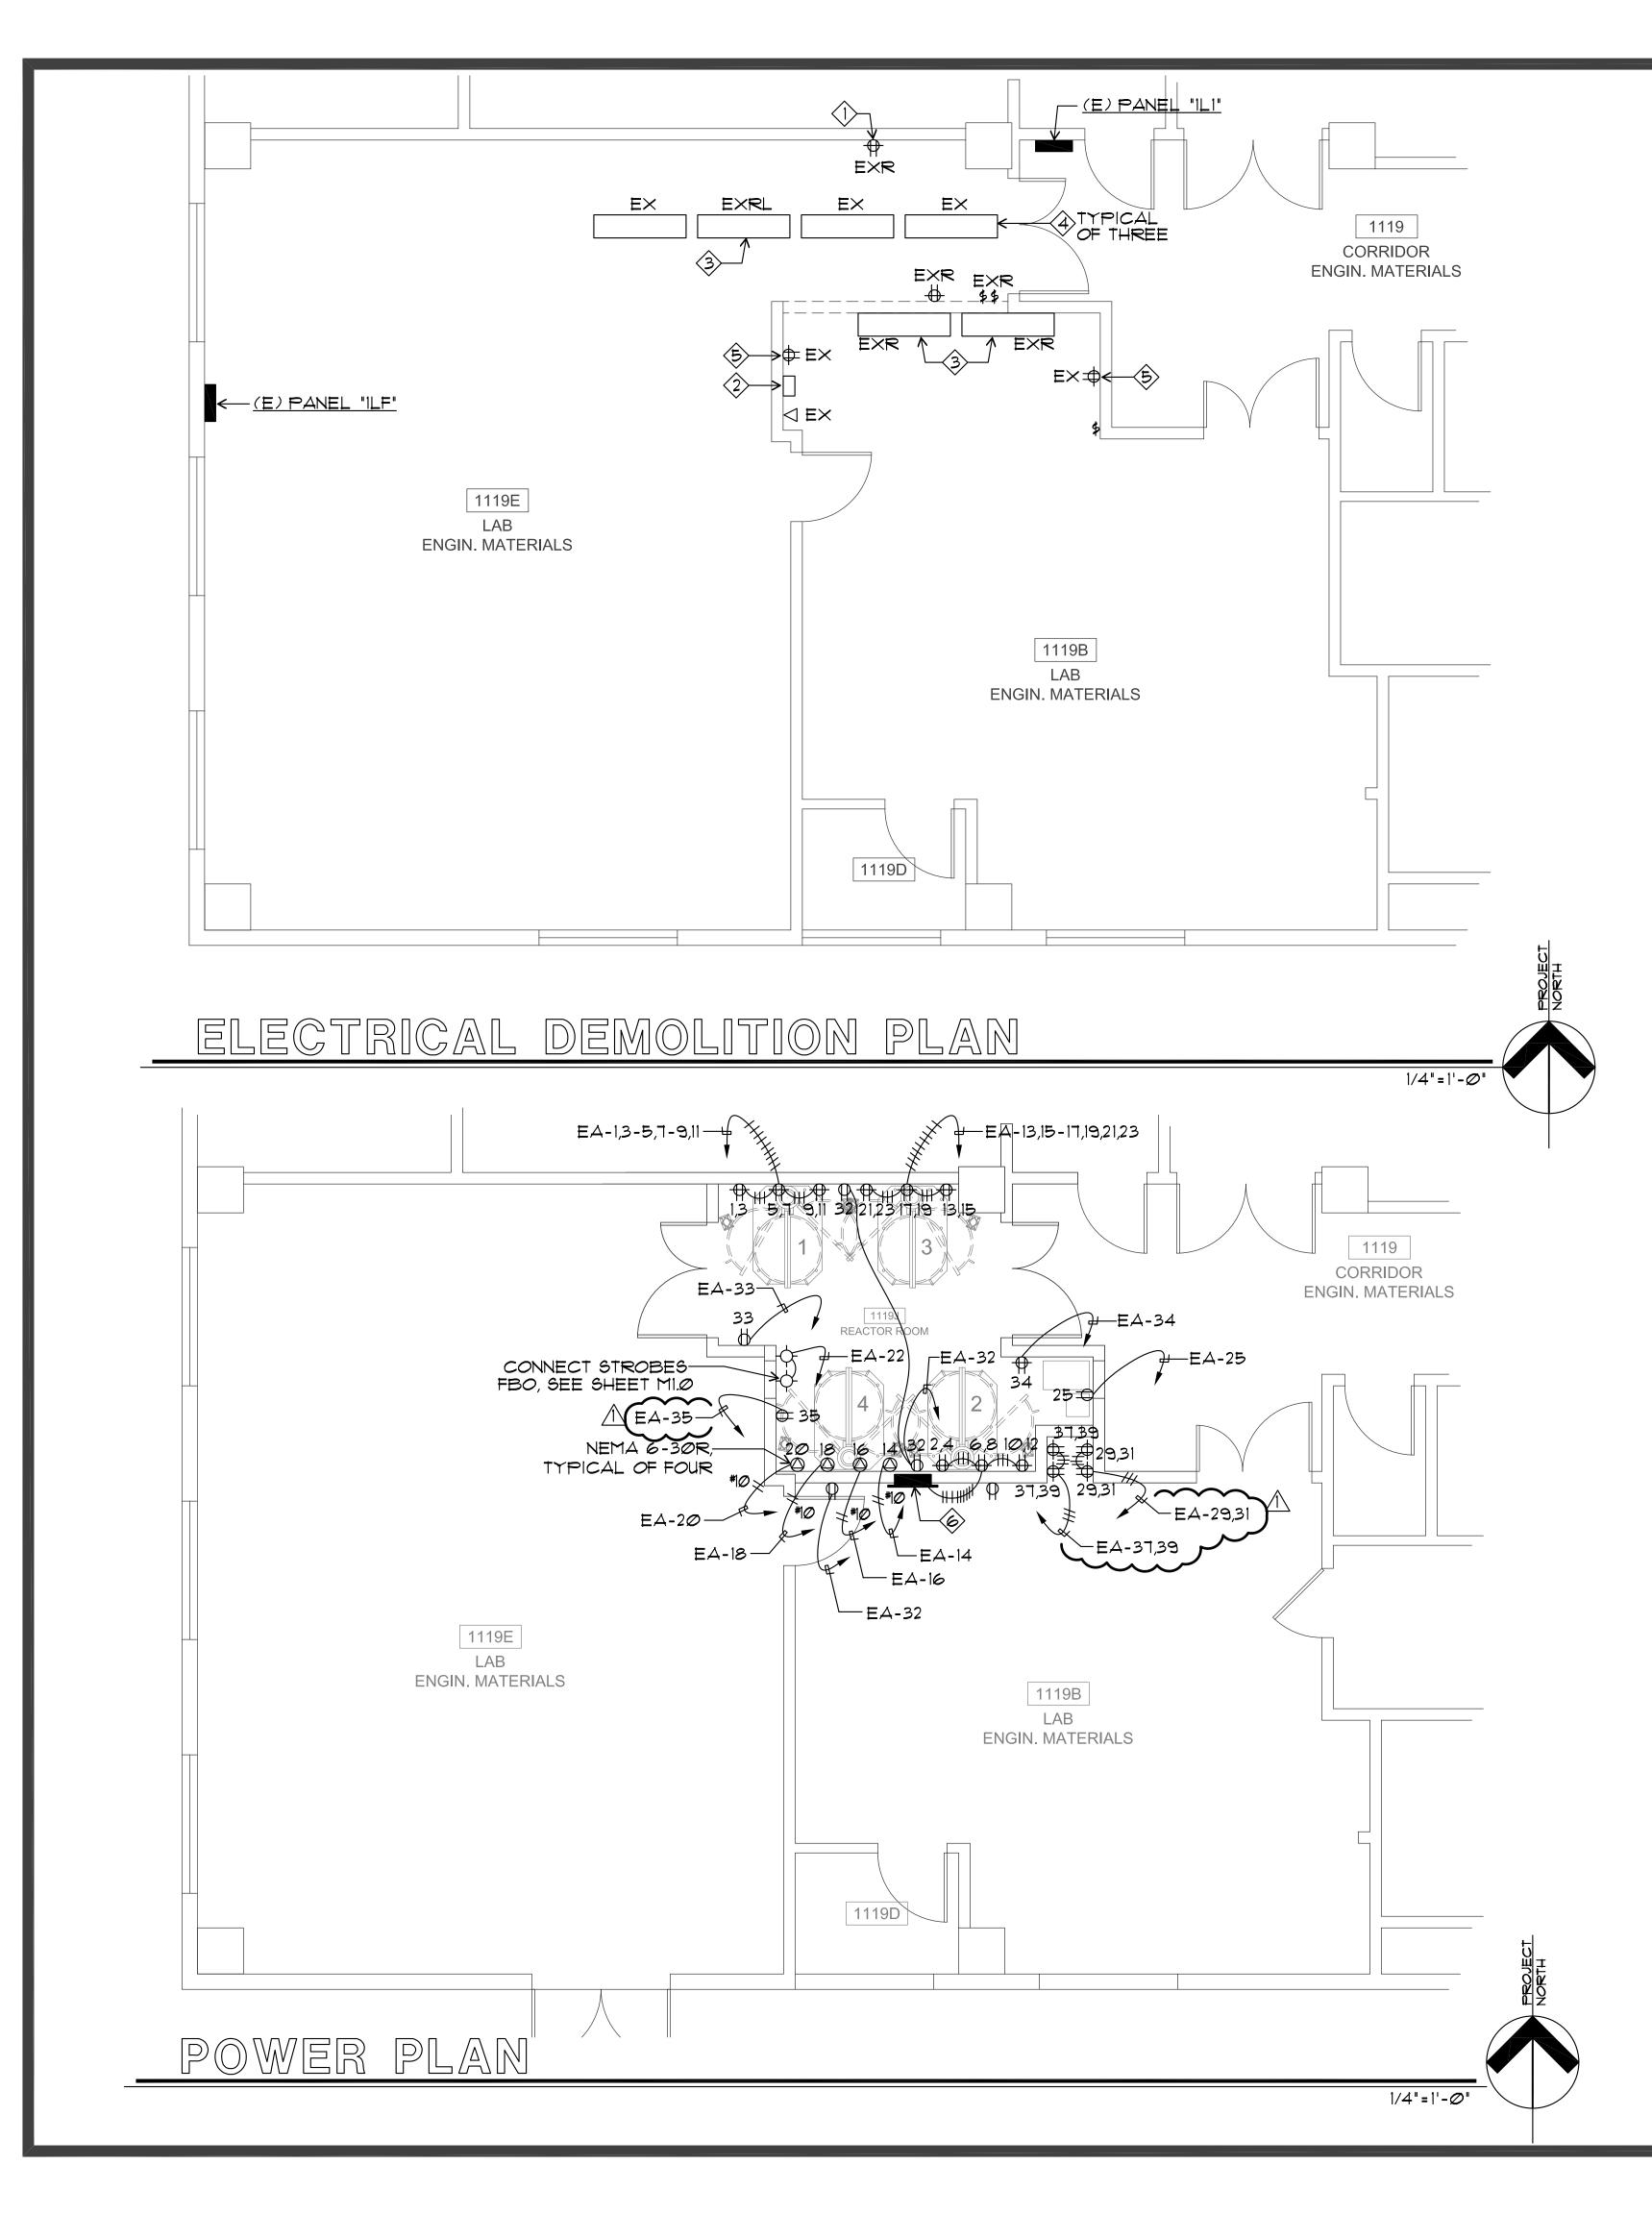


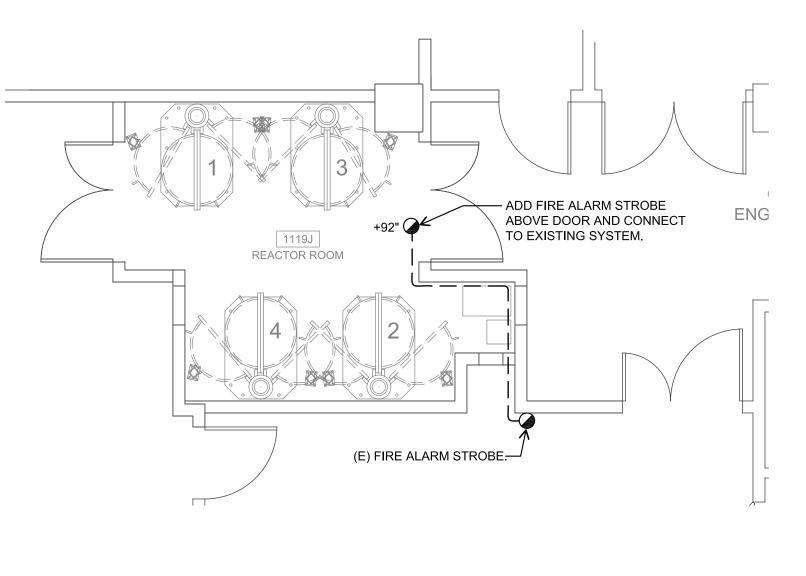FIRE ALARM PLAN

ELECTRICAL NOTES

- DISCONNECT AND REMOVE EXISTING RECEPTACLE. REMOVE ABANDONED RACEWAY AND BRANCH CIRCUIT WIRING BACK TO PANEL, OR NEAREST UPSTREAM DEVICE THAT SHALL REMAIN.
- REMOVE EXISTING 200A DISCONNECT, SALVAGE AND DELIVER TO UNIVERSITY. COMPLETELY REMOVE ABANDONED RACEWAY AND FEEDERS BACK TO PANELBOARD.
- DISCONNECT AND REMOVE EXISTING LIGHT FIXTURE. RELOCATE FIXTURE PER LIGHTING PLAN. SEE SHEET E3.I. REMOVE ABANDONED RACEWAY AND BRANCH CIRCUIT WIRING BACK TO PANEL, OR NEAREST LIGHT FIXTURE THAT SHALL REMAIN.
- EXISTING LIGHT FIXTURE TO REMAIN. SEE LIGHTING PLAN ON SHEET E3.1
- EXISTING RECEPTACLE, TO REMAIN. IF DISTURBED DURING CONSTRUCTION, RECONNECT TO EXISTING CIRCUIT.
- (N) EMERGENCY POWER PANEL "EA". SEE PANEL SCHEDULE ON SHEET EI.O.
- ♦ INTERCEPT (E) LIGHTING CIRCUIT #22 FROM PANEL "IH2O" AND EXTEND TO CONNECT LIGHT FIXTURES AS SHOWN.

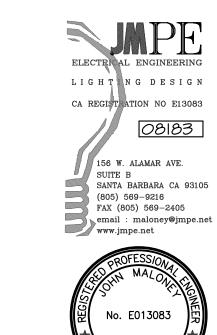

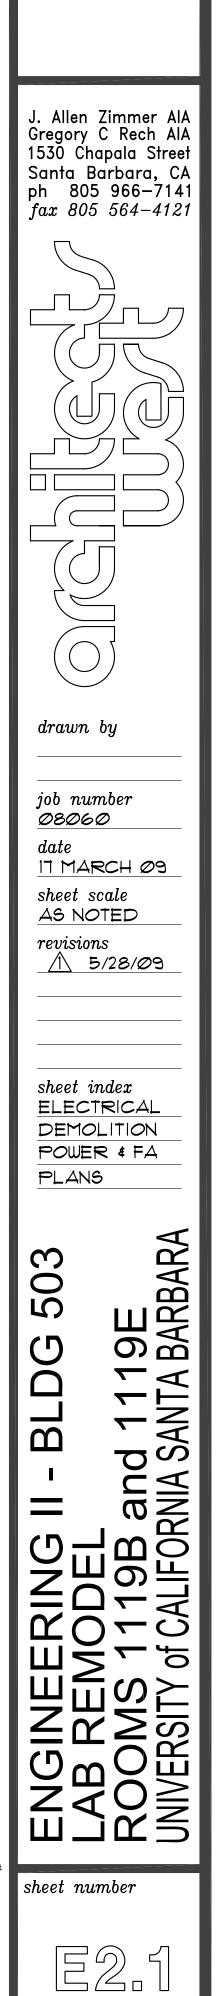

FM090301S/987722

1/4"=1'-Ø"

